ROOF REPLACEMENT - BUILDINGS 100 TO 500

NORTHWOOD ELEMENTARY SCHOOL 2760 EAST TRIMBLE ROAD SAN JOSE, CALIFORNIA

PREPARED FOR BERRYESSA UNION SCHOOL DISTRICT

SCOPE OF PROJECT

- REMOVE EXISTING BUILT-UP ROOF. ABATE AS REQUIRED
- INSTALL NEW BUILT-UP ROOF SYSTEMS.
- INSTALL NEW SHEET METAL FLASHINGS.
- PAINT THE NEW SHEET METAL FLASHING AND GUTTERS.

DRAWING NO TITLE

TITLE SHEET, GENERAL NOTES, ABBREVIATIONS AND LEGEND A1.0


AD2.0 ROOF DEMOLITION PLAN

ROOF SITE PLAN

BUILDINGS 100 AND 200 ROOF PLAN BUILDINGS 300, 400 AND 500 ROOF PLAN

ROOF REPLACEMENT DETAILS ROOF REPLACEMENT DETAILS ROOF REPLACEMENT DETAILS A10.43 ROOF REPLACEMENT DETAILS

DEFERRED SUBMITTALS

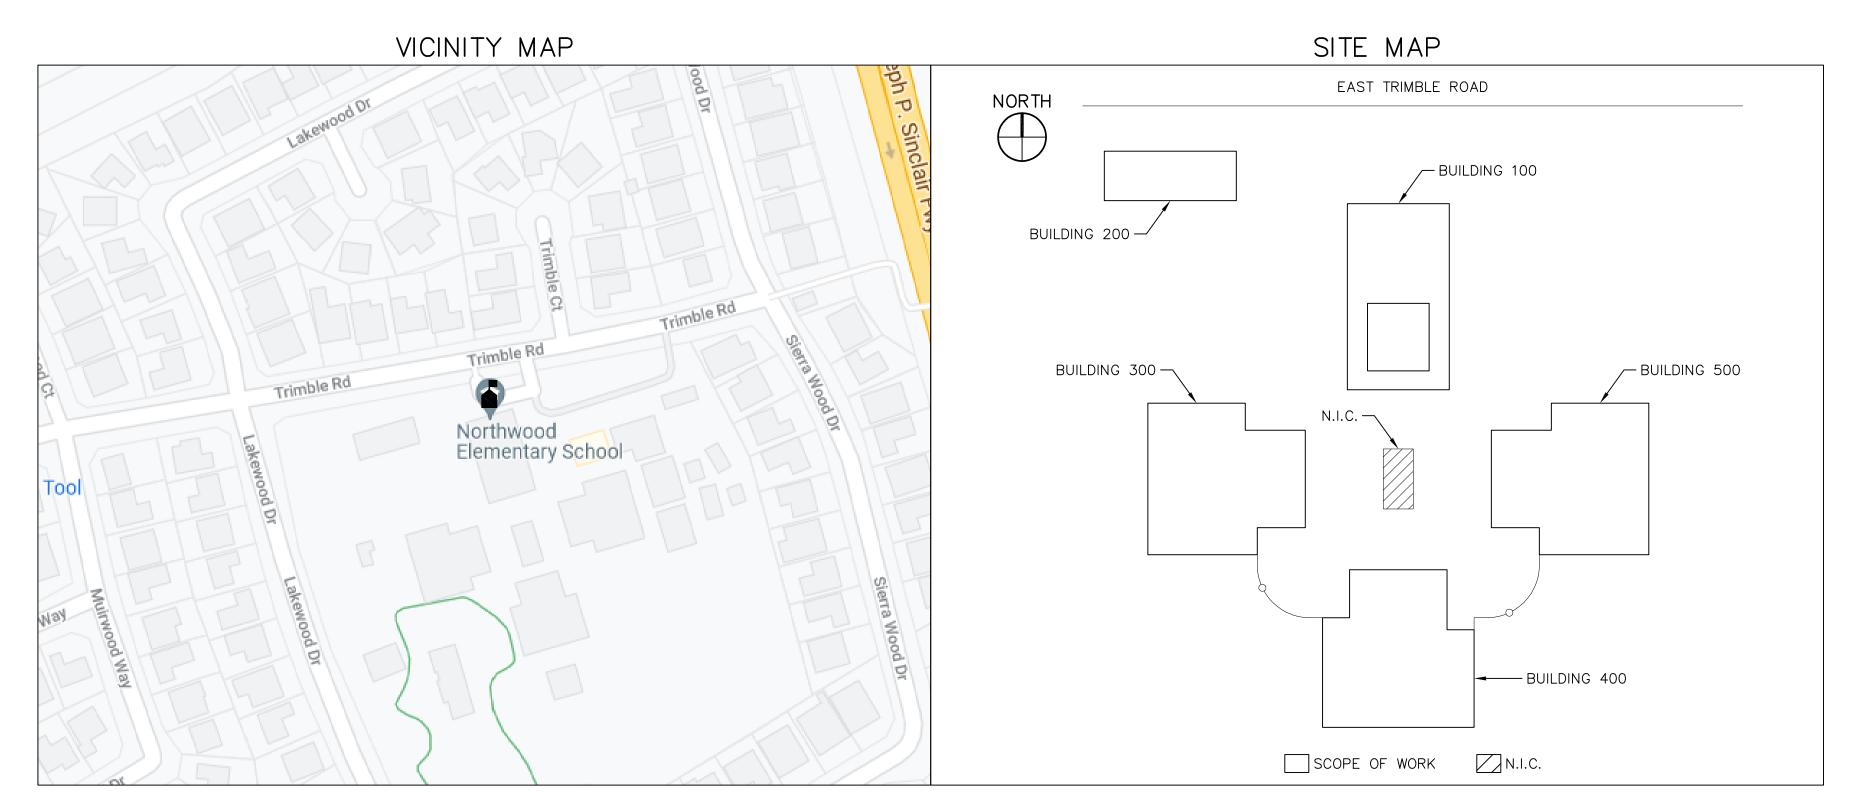

GENERAL NOTES

- (1) THE INFORMATION SHOWN ON THE DRAWINGS WAS COMPILED FROM VARIOUS SOURCES AND MAY NOT REFLECT THE ACTUAL CONDITIONS AT THE TIME OF CONSTRUCTION. THE CONTRACTOR SHALL VISIT THE SITE(S) AND VERIFY DIMENSIONS AND FIELD CONDITIONS PRIOR TO BID
- (2) THE CONTRACTOR SHALL BRING ANY DISCREPANCIES TO THE ATTENTION OF THE OWNER PRIOR
- (3) REFER TO PROJECT SPECIFICATIONS FOR DETAILED REQUIREMENTS FOR MATERIAL AND
- (4) ALL WORK SHALL CONFORM WITH LOCAL, STATE, AND FEDERAL REGULATIONS APPLICABLE TO
- (5) THE CONTRACTOR SHALL OBTAIN ALL NECESSARY PERMITS REQUIRED TO PERFORM THE WORK PRIOR TO THE START OF CONSTRUCTION. THE CONTRACTOR SHALL MAKE SUBMITTALS AS REQUIRED BY THE PROJECT SPECIFICATIONS.
- (7) FOR CLARITY, DETAILS SHOWN IN THESE DRAWINGS ARE TYPICAL AND SHALL APPLY UNLESS OTHERWISE NOTED OR SHOWN. DETAILS OF CONSTRUCTION NOT FULLY SHOWN SHALL BE OF THE SAME OR SIMILAR NATURE FOR SIMILAR CONDITIONS.
- ALL COMPONENTS SHOWN ON THE DRAWING SHALL BE NEW UNLESS INDICATED AS EXISTING (E). THE ARCHITECT/ENGINEER WILL HAVE A REPRESENTATIVE ON-SITE, PART-TIME, DURING CONSTRUCTION TO OBSERVE FOR COMPLIANCE WITH THE DESIGN INTENT AND TO ASSIST THE CONTRACTOR IN RESOLVING VARIATION IN THE EXISTING CONSTRUCTION. THE CONSTRUCTION DOCUMENTS ADDRESS KNOWN CONDITIONS, BUT IT IS ANTICIPATED THAT HIDDEN CONDITIONS WILL BE ENCOUNTERED DURING CONSTRUCTION. THE ARCHITECT/ENGINEER WILL OBSERVE SUCH CONDITIONS AND ISSUE CLARIFICATIONS OR MODIFICATIONS OF EXISTING DESIGN TO REFLECT THOSE CONDITIONS AND DOCUMENT ALL CHANGES.
- (10) NUMERICAL DIMENSIONS SHALL TAKE PRIORITY OVER SCALED. 11) UNLESS OTHERWISE NOTED, ALL ANGLES SHALL BE RIGHT ANGLES, ALL LINES WHICH APPEAR PARALLEL SHALL BE PARALLEL, AND ALL ITEMS WHICH APPEAR CENTERED SHALL BE CENTERED. THE CONTRACTOR SHALL BE RESPONSIBLE FOR MAINTAINING ALL LINES TRUE, PLUMB, AND
- (12) DETAIL DRAWINGS TAKE PRECEDENCE OVER GENERAL AND SMALLER SCALE DRAWINGS. FIGURED DIMENSIONS TAKE PRECEDENCE OVER SCALED DIMENSIONS. THE CONTRACTOR SHALL VERIFY
- ALL SCALED DIMENSIONS BEFORE PROCEEDING WITH THE WORK. (13) THE CONTRACTOR SHALL PROVIDE ALL SHORING AND BRACING NECESSARY TO ENSURE THE
- STABILITY OF ANY AND ALL PARTS OF THE BUILDING CONSTRUCTION. (14) ALL WORK SHALL CONFORM TO 2019 TITLE 24, CALIFORNIA CODE OF REGULATIONS (CCR).

PARTIAL LIST OF APPLICABLE CODES AS OF January 1, 2022*

2019 California Administrative Code (CAC), Part 1, Title 24 CCR* 2019 California Building Code (CBC), Part 2, Title 24 CCR (2018 International Building Code, Vol. 1 & 2, and 2016 California amendments) 2019 California Electrical Code (CEC), Part 3, Title 24 CCR (2014 National Electrical Code and 2016 California Amendments) 2019 California Mechanical Code (CMC), Part 4, Title 24 CCR (2018 IAPMO Uniform Mechanical Code and 2016 California amendments) 2019 California Plumbing Code (CPC), Part 5, Title 24 CCR (2015 IAPMO Uniform Plumbing Code and 2016 California amendments) 2019 California Energy Code (CEC), Part 6, Title 24 CCR 2019 California Fire Code (CFC), Part 9, Title 24 CCR (2018 International Fire Code and 2016 California Amendments) 2019 California Existing Building Code (CEBC), Part 10, Title 24 CCR (2018 International Existing Building Code and 2016 California Amendments) 2019 California Green Building Standards Code (CALGreen), Part 11, Title 24 CCR 2019 California Referenced Standards Code, Part 12, Title 24 CCR Title 19 CCR, Public Safety, State Fire Marshal Regulations

2013 ASME A17.1/CSA B44-13 Safety Code for Elevators and Escalators

PARTIAL LIST OF APPLICABLE STANDARDS

FAILTIAL LIST OF AFFLICABLE STANDARDS		
NFPA 13 Standard for the Installation of Sprinkler Systems (CA amended) NFPA 14 Standard for the Installation of Standpipe and Hose Systems NFPA 17 Standard for Dry Chemical Extinguishing Systems NFPA 17AStandard for Wet Chemical Extinguishing Systems	2013 2013	Edition Edition Edition Edition
NFPA 20 Standard for the Installation of Stationary Pumps for Fire Protection NFPA 22 Standard for Water Tanks for Private Fire Protection	2016	Edition Edition
NFPA 24 Standard for the Installation of Private Fire Service Mains and Their Appurtenances	2016	Edition
NFPA 72National Fire Alarm and Signaling Code (CA amended); NFPA 80 Standard for Fire Doors and Other Opening Protectives NFPA 2001 Standard on Clean Agent Fire Extinguishing Systems	2016 2016	Edition Edition Edition
UL 300 Standard for Fire Testing of Fire Extinguishing Systems for	2010	Larcion
Protection of Commercial Cooking Equipment UL 464 Audible Signaling Devices for Fire Alarm and Signaling Systems,	2005	(R2010
Including Accessories	2003	Edition
UL 521 Standard for Heat Detectors for Fire Protective Signaling Systems		Edition
UL 1971Standard for Signaling Devices for the Hearing Impaired ICC 300Standard for Bleachers, Folding and Telescopic Seating,	2002	Edition
and Grandstands	2012	Edition
For a complete list of applicable NEPA standards refer to 2016 CBC (SEM) Chapter	35 and	4

For a complete list of applicable NFPA standards refer to 2016 CBC (SFM) Chapter 35 and California Fire Code Chapter 80. See California Building Code, Chapter 35, for State of California amendments to the NFPA

*All parts of the 2019 California Building Code become effective January 1, 2020 except the effective date for the use of the 2019 Building Energy Efficiency Standards (Title 24, Part 1, Chapter 10) is February 25, 2020 and the effective date for the use of the California Administrative Code (Title 24, Part 1, Chapter 4) is January 20, 2020.

2010 ADA STANDARDS FOR ACCESSIBLE DESIGN

ROOF GENERAL NOTES

CENTERLINE

ACOUSTICAL

AREA DRAIN

ALUMINUM

BOARD BUILDING BLOCK

BLOCKING BUILT-UP ROOF

CAST IRON

CEILING

CAULKING

CONNECTION

CONTINUOUS COUNTER SUNK

COURTYARD

DIMENSION

DOWNSPOUT

ELEVATION

EXTERIOR

ELECTRICAL

FLOOR DRAIN

FOUNDATION

GALVANIZED

HOSE BIB

GALVANIZED SHEET

HEATING VENTILATION W/O

GYPSUM BOARD

AIR CONDITIONING

FLASHING FOOT OR FEET FOOTING

GAUGE

EXPANSION JOINT

EACH

(E) OR EXIST EXISTING

CENTER

CONSTRUCTION

COLUMN CONCRETE

APPROXIMATE

ARCHITECTURAL

AL. APPROX

ARCH.

CONN. CONSTR CONT.

DIAMETER/ROUND

AIR CONDITIONING

POUND OR NUMBER

(1) REFER TO THE PROJECT MANUAL FOR WATERTIGHTNESS REQUIREMENTS AFTER ROOF DEMOLITION. (2) REFER TO THE ROOF TYPE DETAILS FOR ROOF SYSTEM COMPONENTS (1/A10.40). (3) REPORT UNSUITABLE SUBSTRATE CONDITIONS TO THE OWNER. DO NOT INSTALL ROOFING OVER

> INSIDE DIAMETER INTERIOR JOINT LIGHT JOINT

MAXIMUM

MEMBRANE

MINIMUM

MIRROR

MULLION

NUMBER

NOT TO SCALE

ON CENTER OUTSIDE DIAMETER

OVERFLOW

PLYWOOD

PRE-CAST

ROOF DRAIN

REFERENCE

REINFORCED REGISTERED

SCHEDULE SECTION

SIMILAR

SHEET METAL

STANDARD

SUSPENDED

SYMETRICAL

WATER CLOSET

WITHOUT WEIGHT

SPECIFICATION

STAINLESS STEEL

TONGUE AND GROOVE

UNLESS NOTED OTHERWISE

RAIN WATER LEADER

SOUTH OR SKYLIGHT

NEW

NOM. N.T.S.

PLYWD


R.W.L.

T & G

MANUFACTURER

MISCELLANEOUS

SYMBOLS

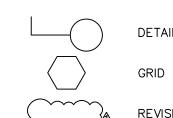

LEGEND			
_	ROOF EDGE	ф×	SUMP WITH DRAINS
	GUTTER WITH DOWNSPOUT	- 	DRAIN
=	PARAPET WALL	×	OVERFLOW
	EXISTING RIDGE/VALLEY LINE	•	DOWNSPOUT
	CRICKET LINE][SCUPPER OR OVERFLOW SCUPPER
<u></u>	CONDUIT(S) PIPES	F	ANTENNA
	ON WOOD SLEEPERS	\circ_{f}	FLUE
	EXPANSION JOINT	0	PLUMBING VENT
F	FAN UNIT	_ි ර් ර	ELECTRICAL PENETRATION
H \square	HATCH	$\mathcal{C}^{\mathcal{O}}$	GAS PENETRATION
S	SKYLIGHT	P	ROOF MOUNTED SPEAKER/ALARM
J	J-VENT		ROOF MOUNTED LIGHT
SM	SMOKE HATCH	$\triangle \bullet^{A}$	ABANDONED PENETRATION
$\Diamond \nabla \nabla $	VENT UNIT	⊘ HS	HOT STACK
D	DUCT PENETRATION	EL.=#	ELEVATION
⊗	GRAVITY VENT	\rightarrow	SLOPE (DOWNWARD)
	SLEEPER, HEAVY AND FLOATING	#	ROOF CROSS-SECTION INDICATOR
H۱	ROOF DRAIN LEADER EXIT		DUCTWORK
AC	HVAC UNIT	B	BOX
Р	PLATFORM	\vdash	LADDER
\boxtimes	GANGED PENETRATION	GREY	EXISTING COMPONENT

AV ATTIC VENT

SECURITY CAMERA

Steelhead Engineers, Inc Consulting+Design

2708 Wasatch Drive Mountain View, Ca 94040 P 650.941.1112 F 650 396 4000 steelheadengineers.com

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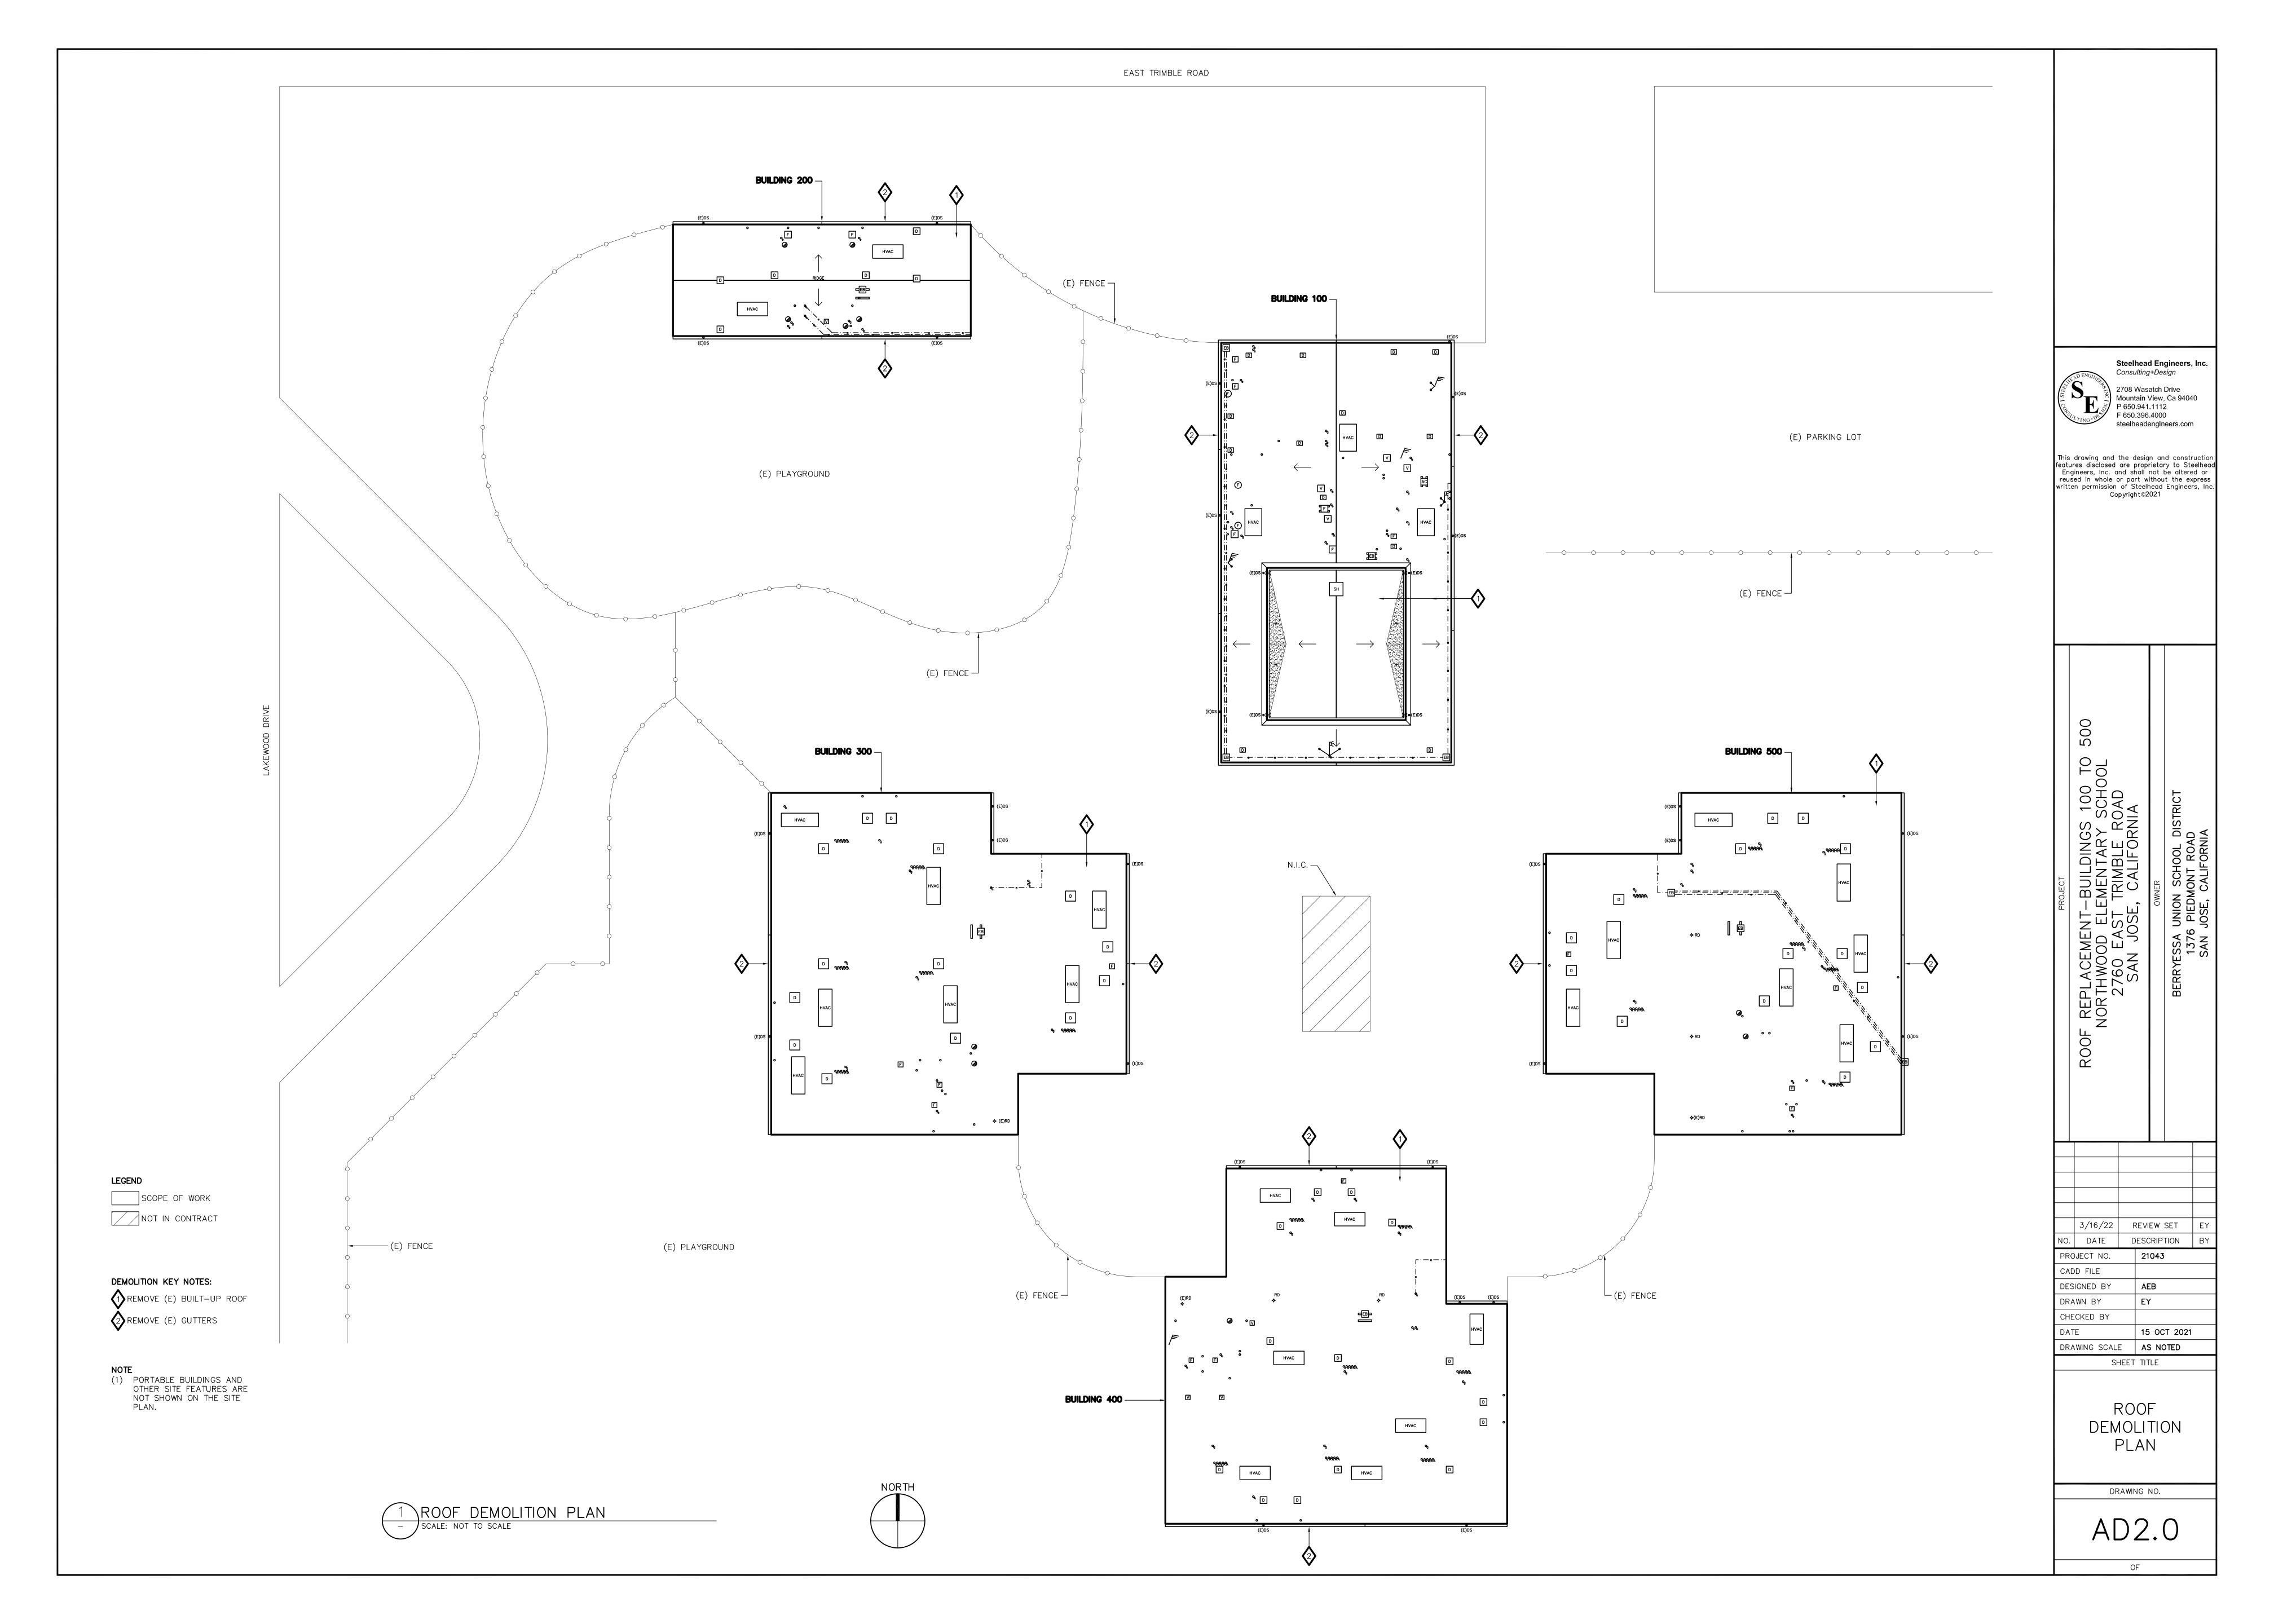
TITLE SHEET GENERAL NOTES, **ABBREVIATIONS** AND LEGEND


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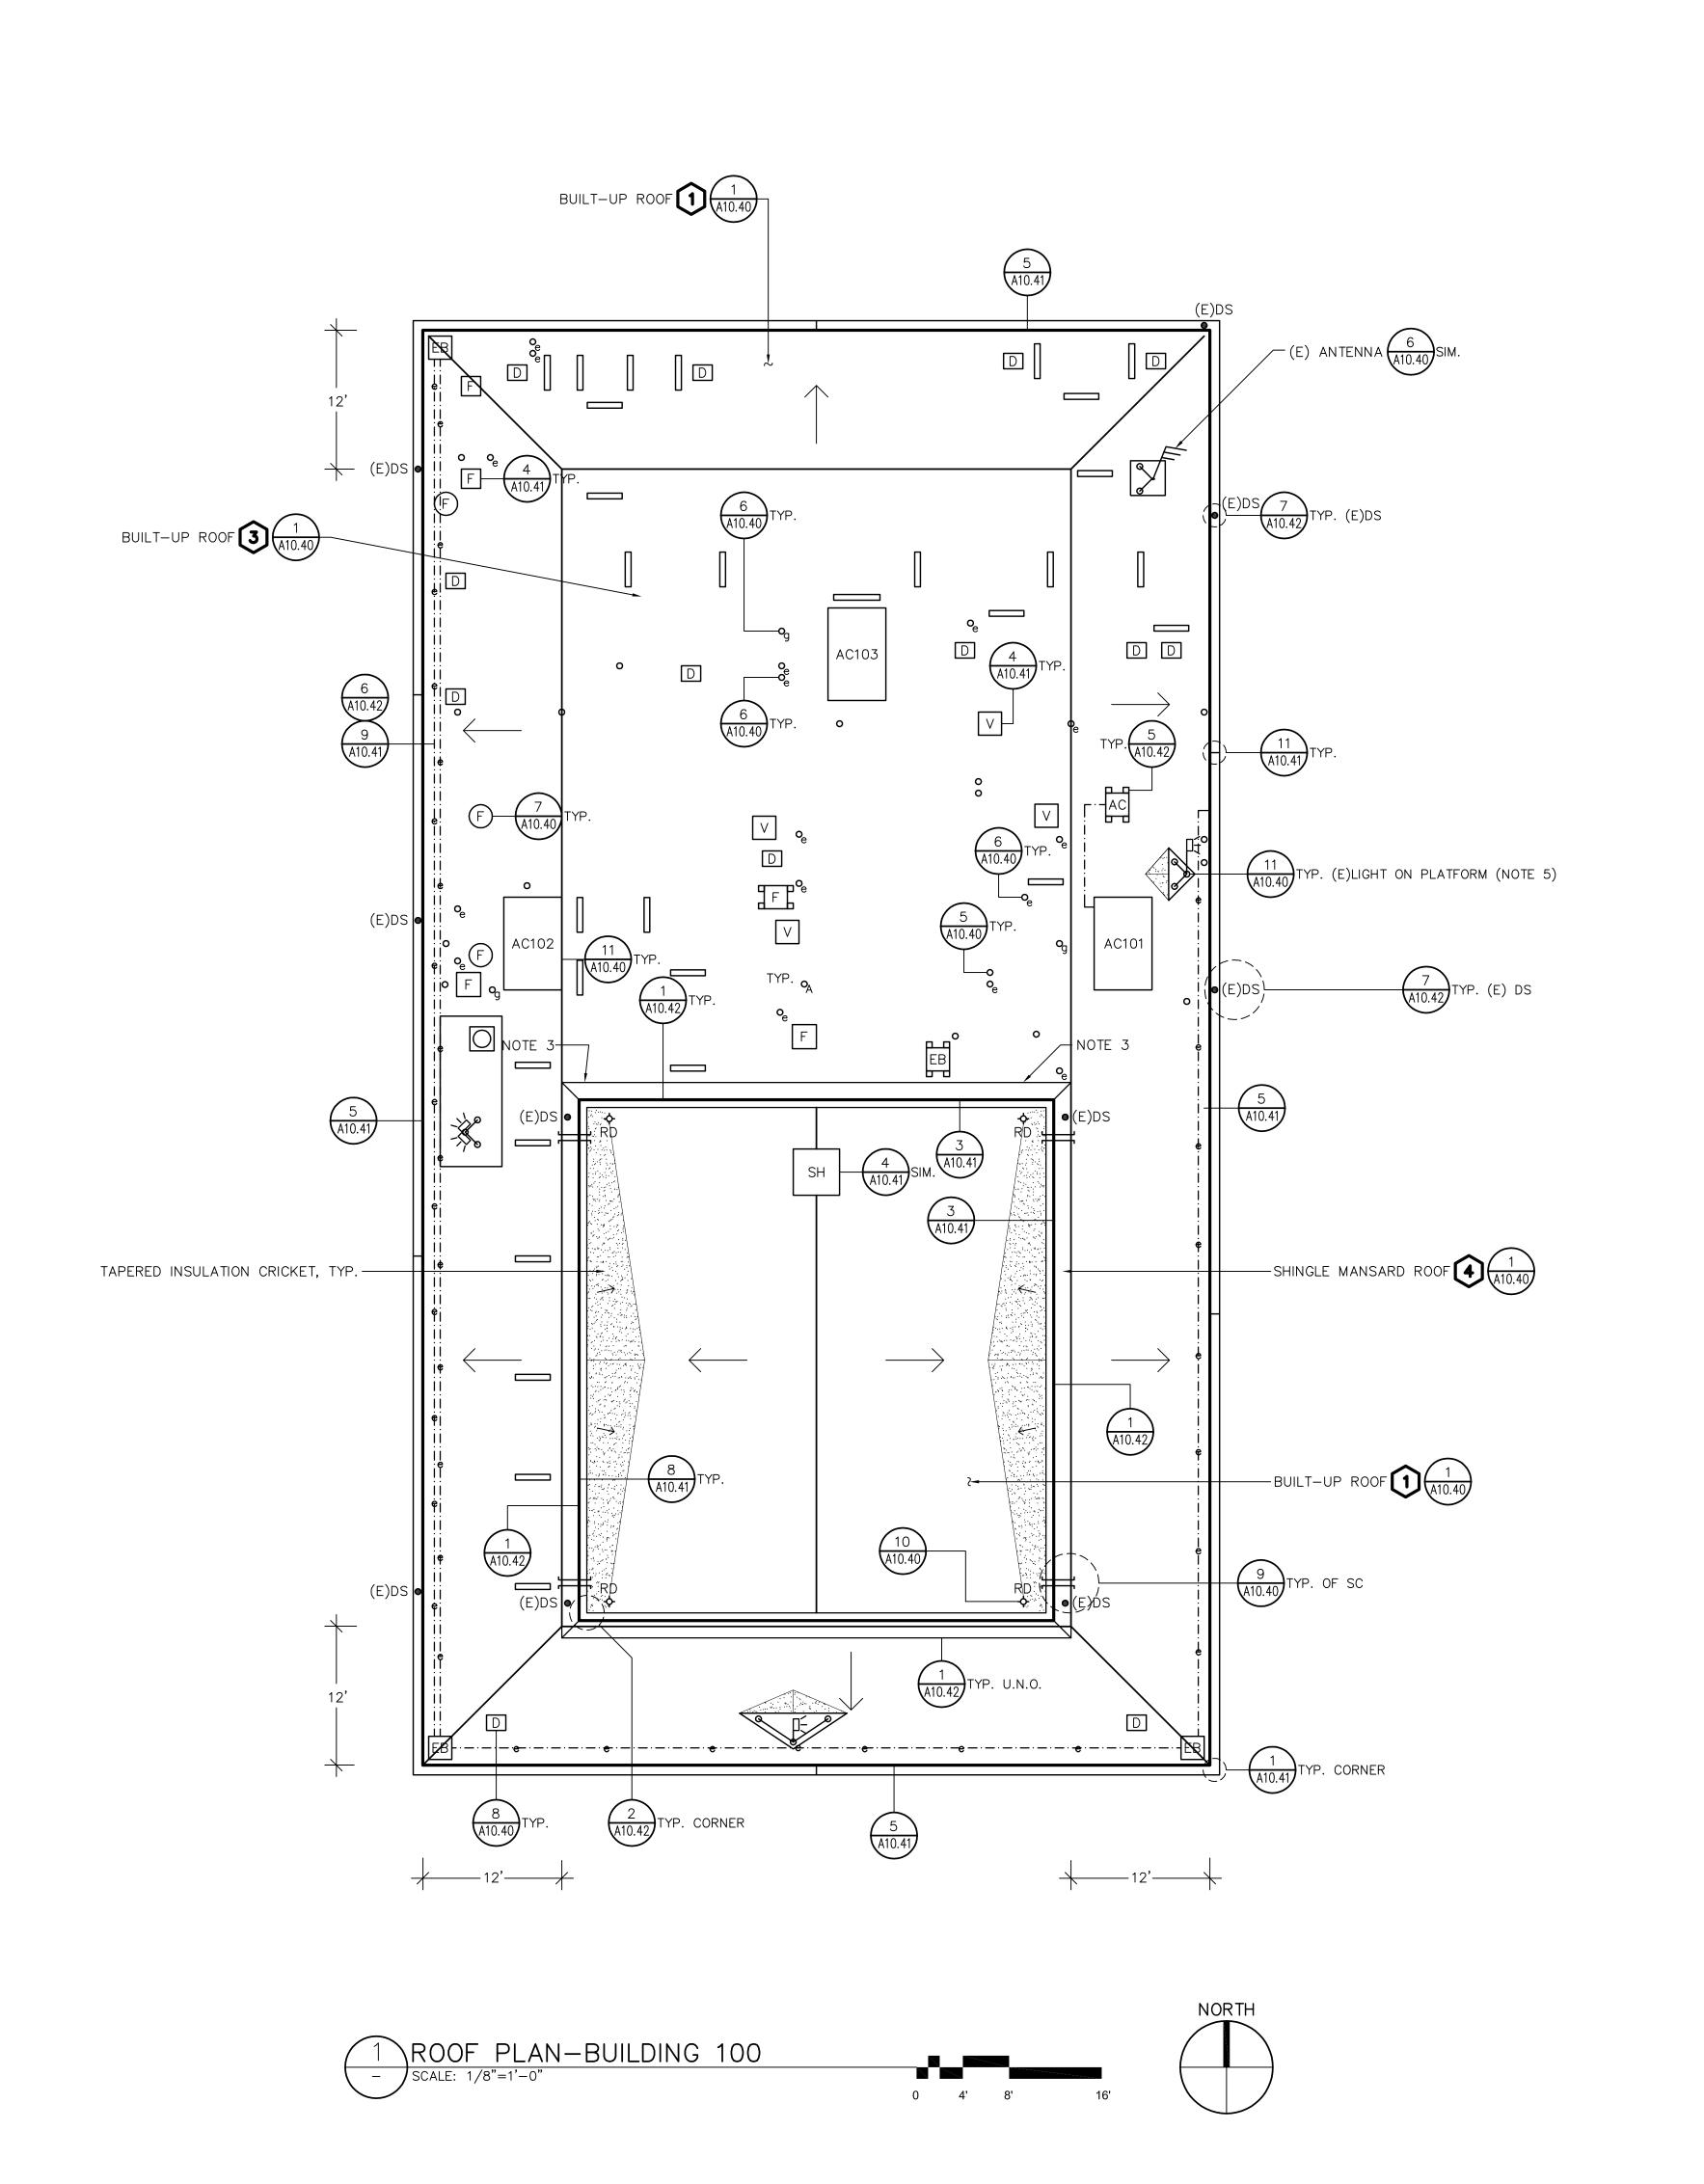
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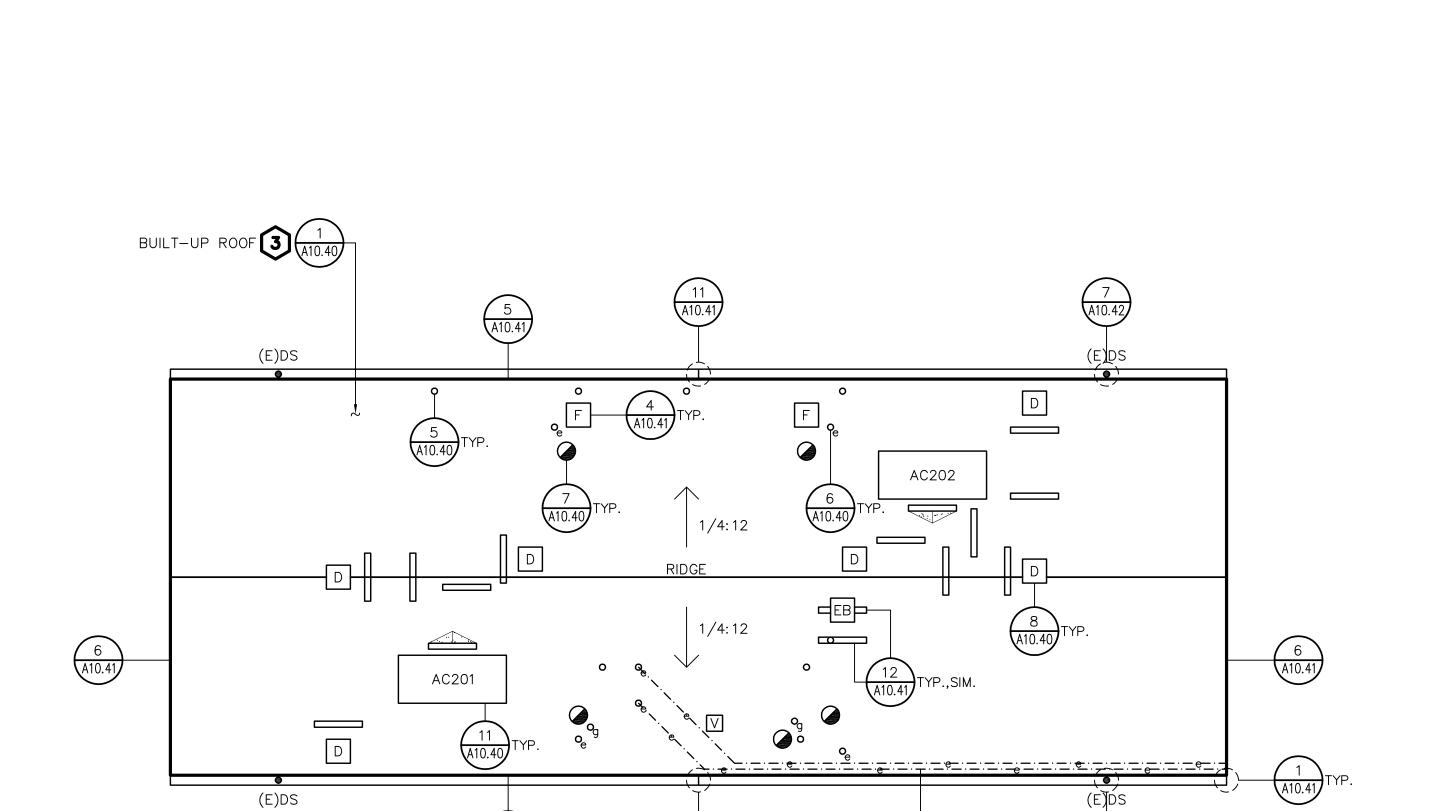
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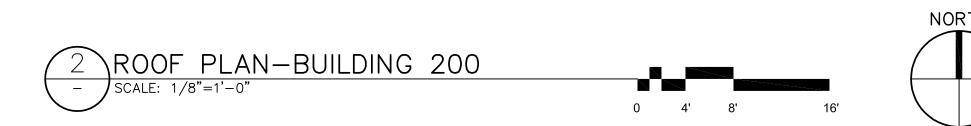








(1) REMOVE AND REINSTALL SHEET METAL AS REQUIRED TO INSTALL EDGE METAL. SET COVER FASTENERS IN SEALANT.
(2) INSTALL GSM DIVERTER AT MANSARD/DUCT INTERFACE (2 LOCATIONS).
(3) REFER TO DETAIL 11/A10.41 FOR DUCT CURB FLASHING.

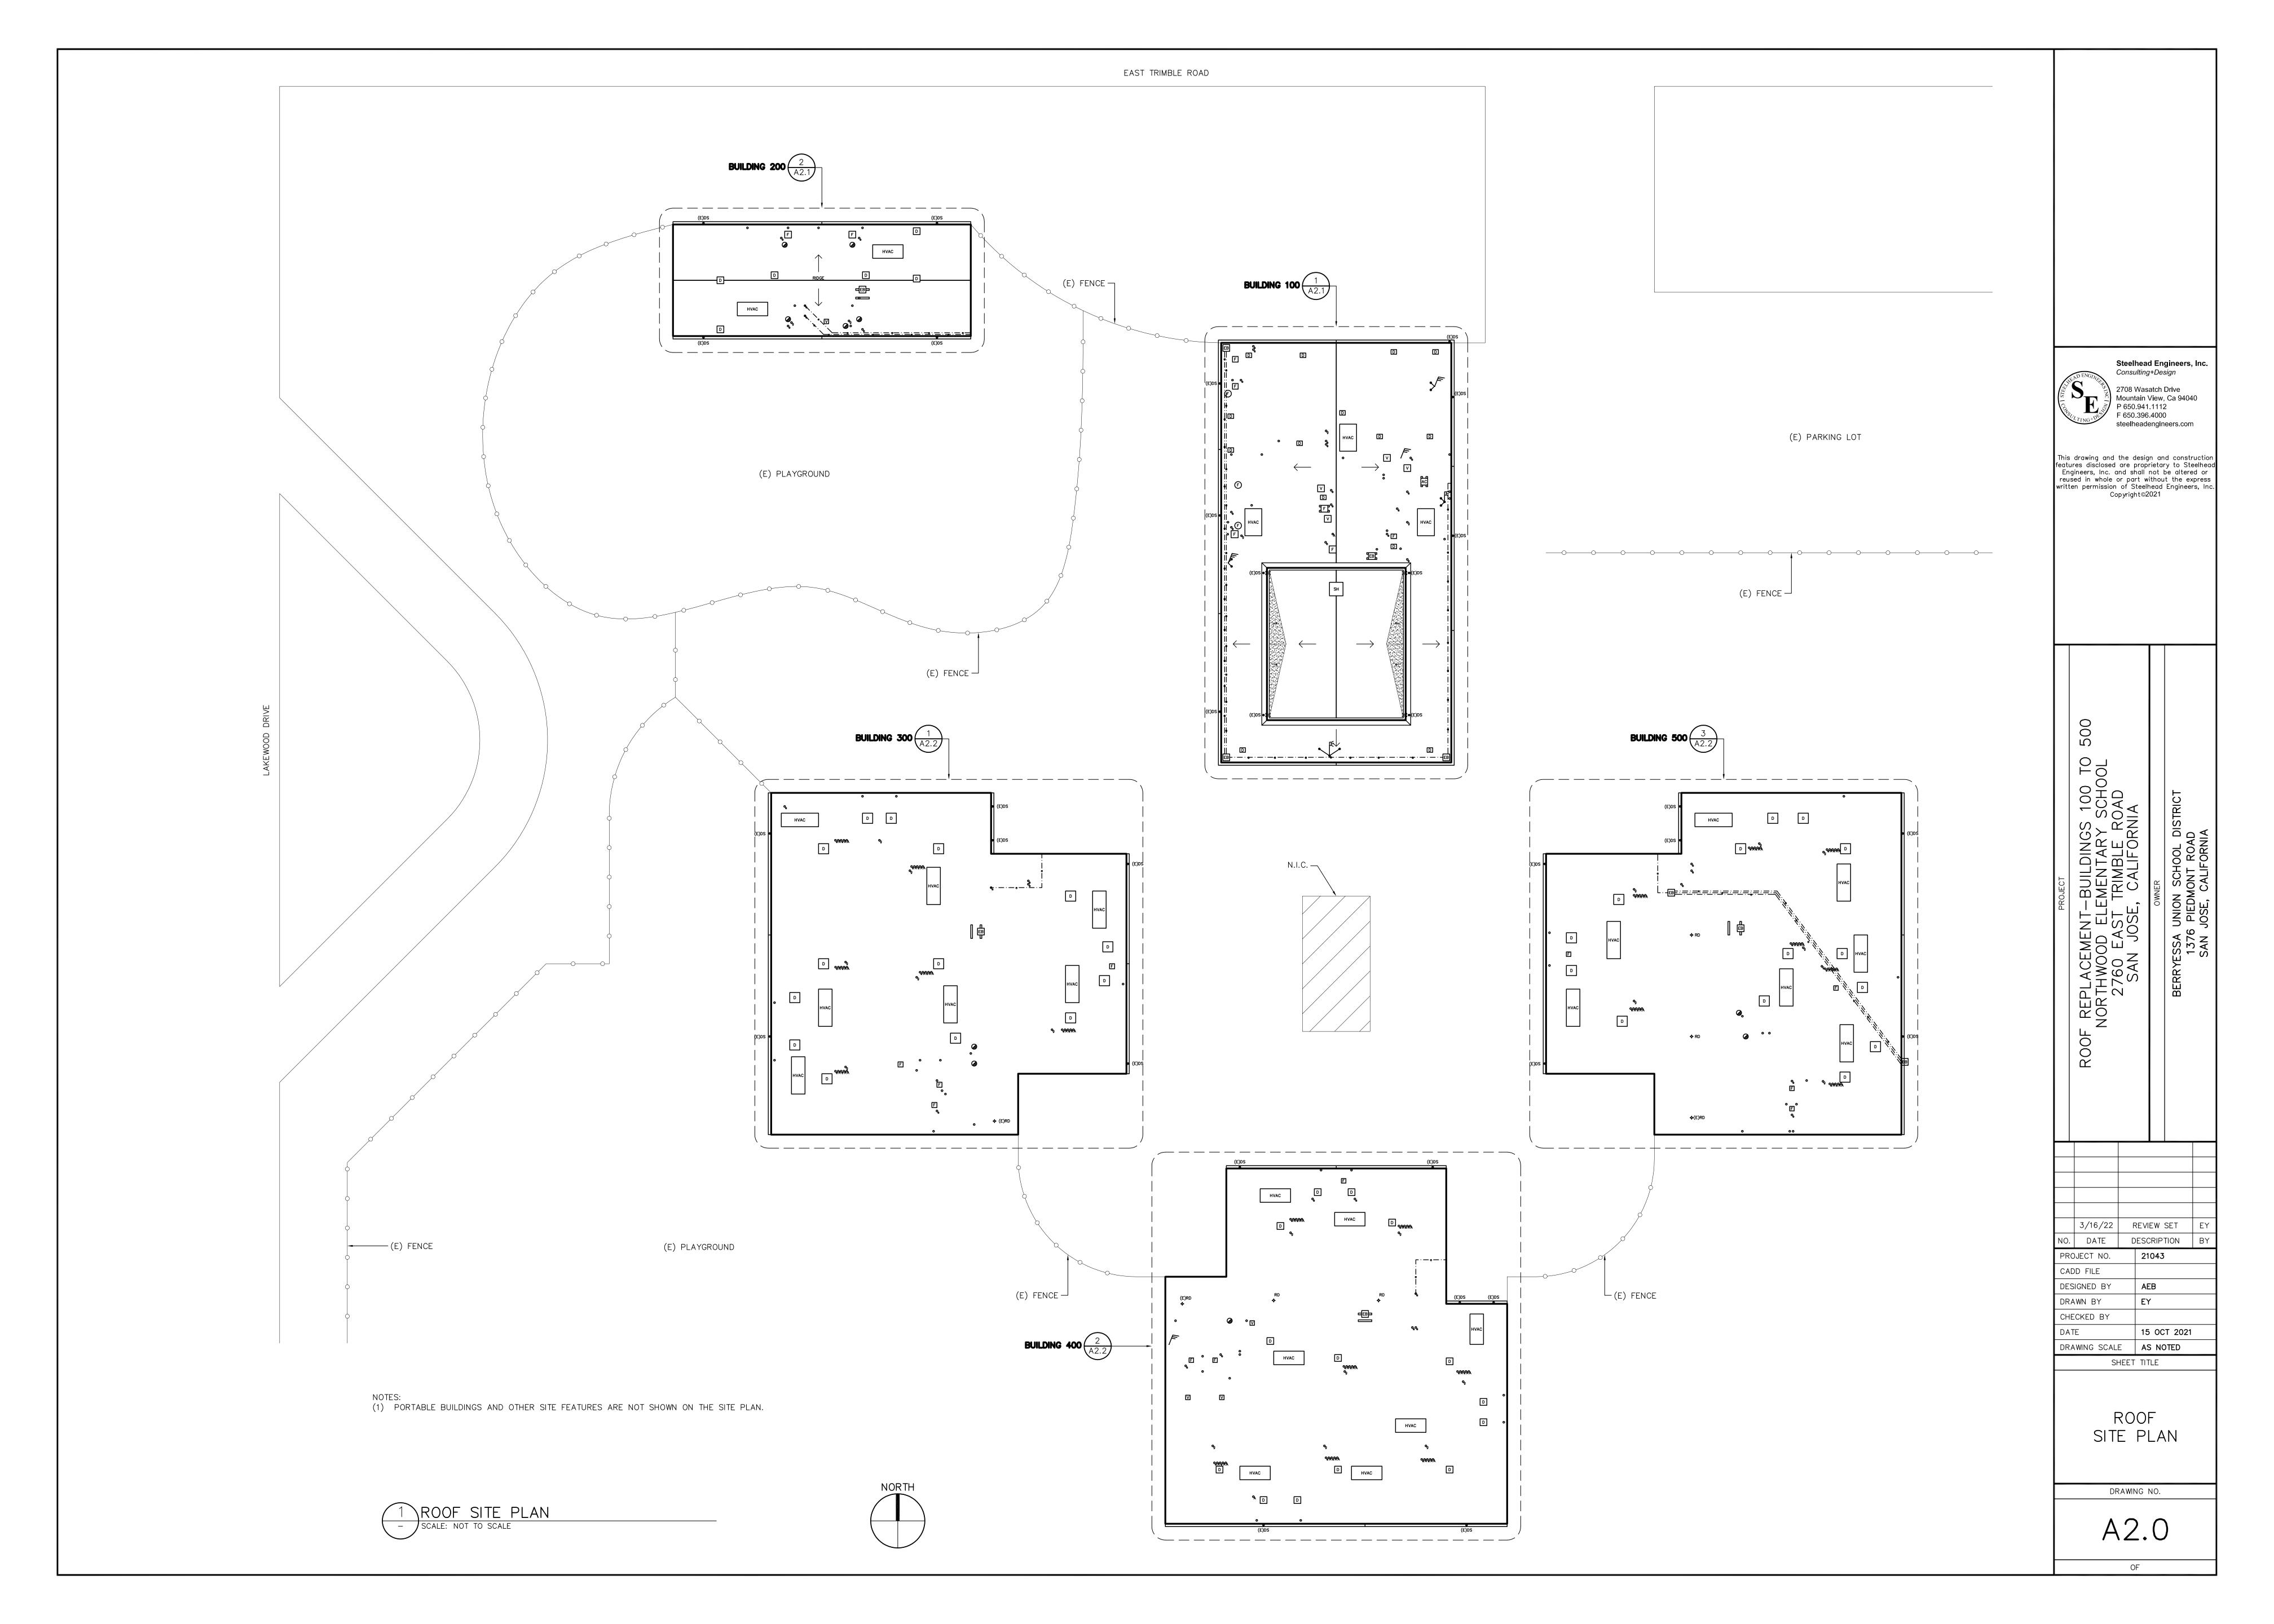

REVIEW SET

NOT FOR CONSTRUCTION



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DRAWING SCALE AS NOTED

SHEET TITLE

ROOF PLANS BUILDINGS 100 AND 200

DRAWING NO.

A2.1

OF

